

INISH SCHEDULE						
MARK	SURFACE / FINISH	LOCATION	PRODUCT / MATERIAL	MAKE / MODEL	ASSEMBLY SYSTEM	REMARKS
OORING						
1	FLOORING	THROUGHOUT	EXISTING CONCRETE TO REMAIN.			CLEAN AFTER MAT REMOVAL.
ASE						
1	BASE	THROUGHOUT	RUBBER BASE	4" TOPSET RUBBER BASE. COIL BURKE MERCER, COLOR: BLACK		
/ALLS						
<b>'-1</b>	DRYWALL AND PLASTER SURFACES THROUGHOUT	THROUGHOUT	EXISTING TO REMAIN. REPAINT	DUNN EDWARDS. PAINT COLOR: DET 673 MISSION WHITE.	PREP SURFACE PER SPECIFICATION. ONE COAT PRIMER AND TWO FINISH COATS.	
<b>7-2</b>	DRYWALL AND PLASTER SURFACES THROUGHOUT	THROUGHOUT	EXISTING TO REMAIN. REPAINT	DUNN EDWARDS. PAINT COLOR: EVSH50 FOREST GREEN	PREP SURFACE PER SPECIFICATION. ONE COAT PRIMER AND TWO FINISH COATS.	
EILINGS						
1	ACOUSTICAL GLUE-ON CEILING TILE	THROUGHOUT	EXISTING TO REMAIN. REPAINT	DUNN EDWARDS. PAINT COLOR: DET 673 MISSION WHITE.	PREP SURFACE PER SPECIFICATION. ONE COAT PRIMER AND TWO FINISH COATS.	PAINT ACOUSTICAL TILE FINISH.
ISCELLANEOUS						
	WINDOW FRAME AND STEEL MESH	THROUGHOUT	EXISTING TO REMAIN. REPAINT	DUNN EDWARDS. PAINT COLOR: DET 673 MISSION WHITE.	PREP SURFACE PER SPECIFICATION. ONE COAT PRIMER AND TWO FINISH COATS.	
	LIGHT FIXTURES	THROUGHOUT	CHANGE LIGHT TUBES AND LENSES, EXISTING HOUSING TO REMAIN	LINMORE LED LIGHT TUBES: LL-T8-4-2-ED-F-41K AND LL-DR-36W-T2-DIM	(2) 4'-O" TUBES WITH 36 WATT DRIVER	REPLACE MISSING OR BROKEN HOUSING WHER OCCURS.

## **GENERAL NOTES - FLOOR PLAN & RCP**

1. PROGRAM OF TWO EXISTING ROOMS TO BE REVERSED: ROOM 36 TO BECOME WEIGHT ROOM, AND ROOM 35 TO BECOME WRESTLING ROOM.

- 2. CONTRACTOR SHALL PAINT (E) UTILITIES, PIPING, CONDUIT, OR WIRING, TYPICAL THROUGHOUT.
- 3. SEE INTERIOR ELEVATIONS FOR MORE INFORMATION ON PAINT AREAS, WALL SURFACES, AND
- 4. MECHANICAL, ELECTRICAL, PLUMBING, TELECOM, AND FIRE ALARM SYSTEMS SHALL REMAIN FUNCTIONAL & BE PROTECTED DURING CONSTRUCTION.
- 5. PROVIDE MATERIAL FINISHES ON ALL SURFACES AS NOTED ON FINISH SCHEDULE AND THROUGHOUT THESE DRAWINGS.
- 6. REPAIRED & NEW GYPSUM BOARD FINISH SHALL ALIGN WITH EXISTING ADJACENT CONSTRUCTION
  - TO RESULT IN FLUSH FINISHES, TYPICAL THROUGHOUT.
- 8. PATCH AND REPAIR ALL EXISTING WALL SURFACES TO REMAIN ADJACENT AREAS OF DEMOLITION.


## **LEGEND - FLOOR PLAN & RCP**

7. CLEAN AND PAINT ROOF VENTS.

(E) WALL OR PARTITION TO REMAIN


## **KEYNOTES - FLOOR PLAN & RCP**

- (1) REMOVE (E) LOCKERS. REPAIR AND PAINT WALL BEHIND.
- 2 REMOVE (E) FLOOR MAT. CLEAN FLOOR BELOW.
- 3 REMOVE (E) SIGNAGE AND REINSTALL SIGNAGE AT THE NEW LOCATION, ABOVE ENTRY DOOR.
- 4 REPLACE (E) LIGHT FIXTURES WITH LED. SEE FINISH SCHEDULE.
- 5 REPLACE (E) BROKEN HVAC REGISTER AT GRAVITY VENT. PAINT TO MATCH CEILING. 6 (E) SUSPENDED DUCTWORK TO REMAIN. PRIME AND PAINT.

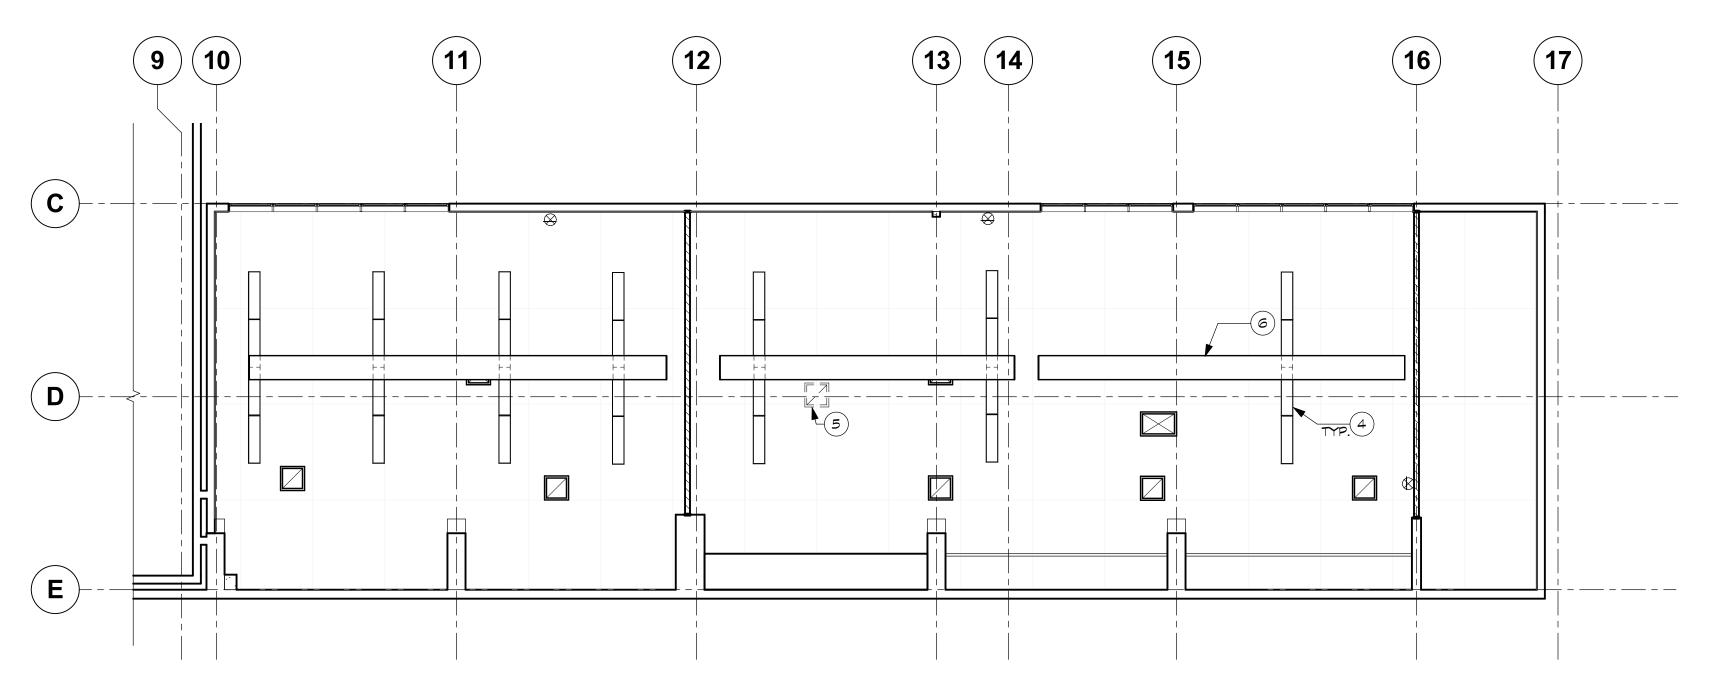

REFLECTED CEILING PLAN

SCALE: 1/8" = 1'-0"

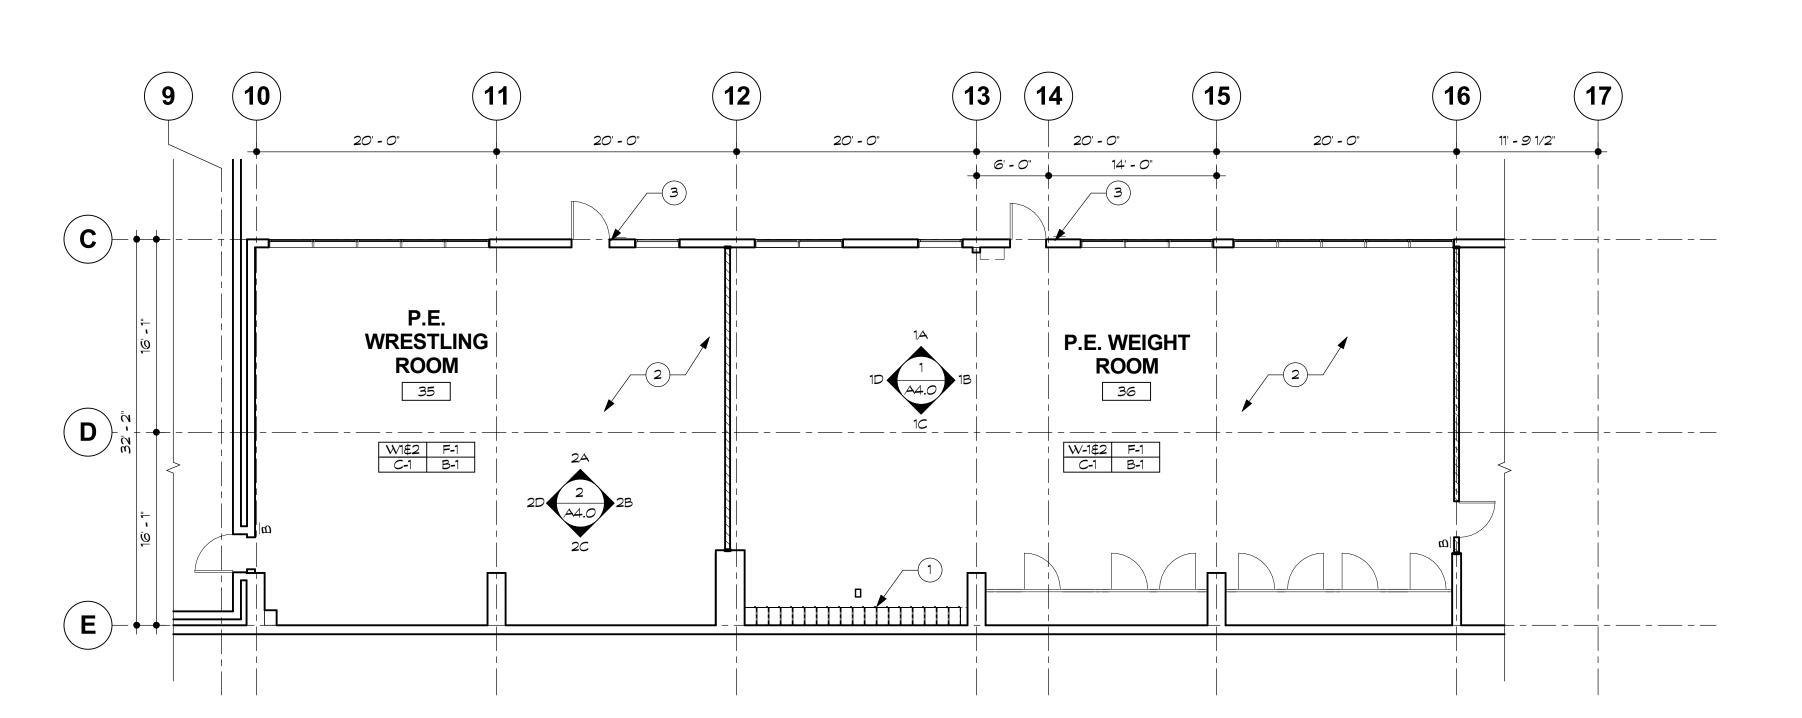

FLOOR PLAN

SCALE: 1/8" = 1'-0"

CODY ANDERSON WASNEY

ARCHITECTS

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CONSULTANTS

DATE MILESTONE 08/15/2016 08/19/2016

PROJECT NAME

JAMES LICK HIGH SCHOOL **BUILDING 1200 NEW-TECH MATHEMATICS / PHYSICAL** 

**EDUCATION CLASSROOM** 

**JAMES LICK HIGH SCHOOL** 

57 NORTH WHITE RD


SAN JOSE, CA 95127

SHEET TITLE

**PLANS & FINISH SCHEDULE** 

DRAWN BY K LANGE CHECKED BY B MCCLURE

A1.0

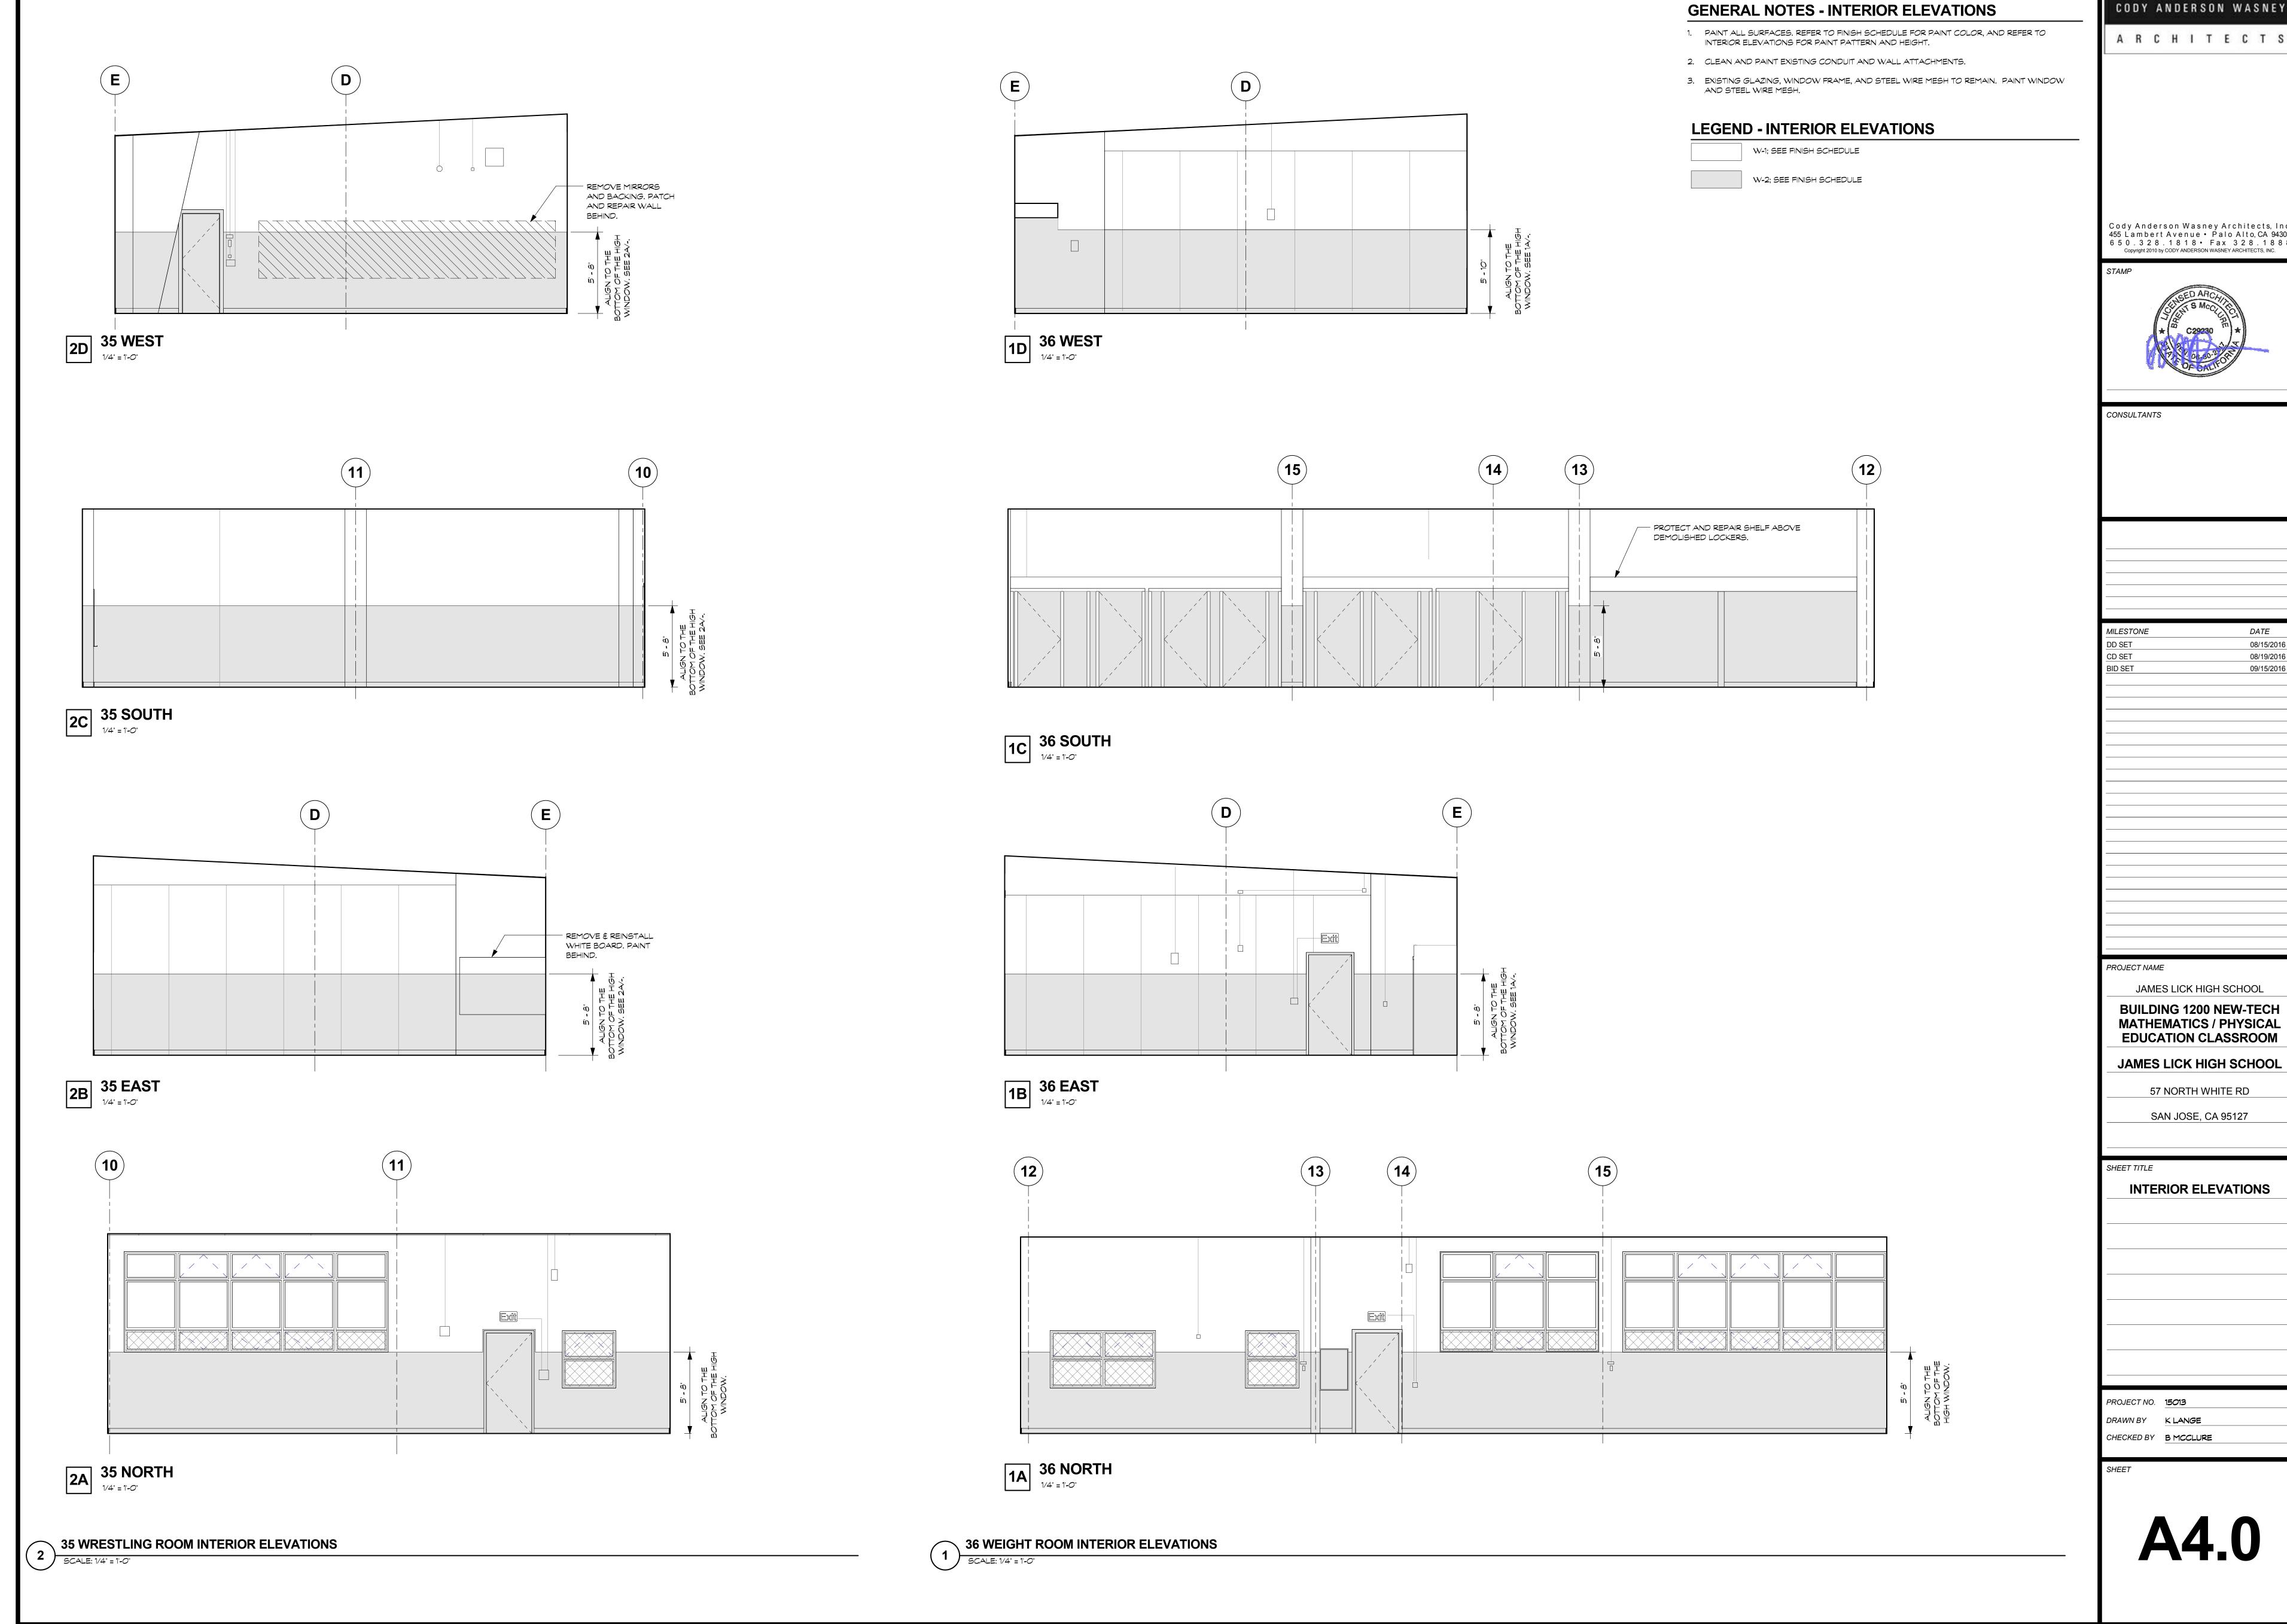

**GENERAL NOTES - INTERIOR ELEVATIONS** 

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DATE 08/15/2016 08/19/2016

JAMES LICK HIGH SCHOOL

BUILDING 1200 NEW-TECH MATHEMATICS / PHYSICAL **EDUCATION CLASSROOM** 

**JAMES LICK HIGH SCHOOL** 

57 NORTH WHITE RD

SAN JOSE, CA 95127

**INTERIOR ELEVATIONS** 

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